





USB SQE 55 DRAWING RELEASE

We are very excited to release the V3 set of US Smart Building (USB) drawing sets. The Smart Building has a number of design enhancements new to the Wendy's fleet of restaurants.

Some of these design enhancements are:

- Blade lighting slip sheet added. (Test letter required, call Manager of Design)
- Awning design updated
- Urinal added in Men's Restroom.
- Signature Red Blade with fireplace and TV.
- Large variety of seating types
- New community table design.
- Single use restrooms c/w baby change stations in each restroom.
- New single line DSG with integrated chicken grill.
- New sandwich station design.
- Area for future Ware wash added.
- Standardization of the core kitchen layout
- · Foundation design updated
- IFS panel (integrated electrical panel) with updated controls.
- Integrated ICS box with Dry Storage, Cooler and Freezer.
- Office Door and wall added. (door optional).
- IFS panel curb detail changed
- Electrical & control panel updated

NOTE: To access the US Smart Building CAD files, the Franchisee must apply to participate in an Early Adaptor Program (EAP) by contacting their Manager of Design. There is no cost to participate in the EAP.

Contact Information
Wendy's Restaurant Support Center

Trevor Wright USB PROGRAM LEAD


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View toward dining area



View toward fire place



SQE 55

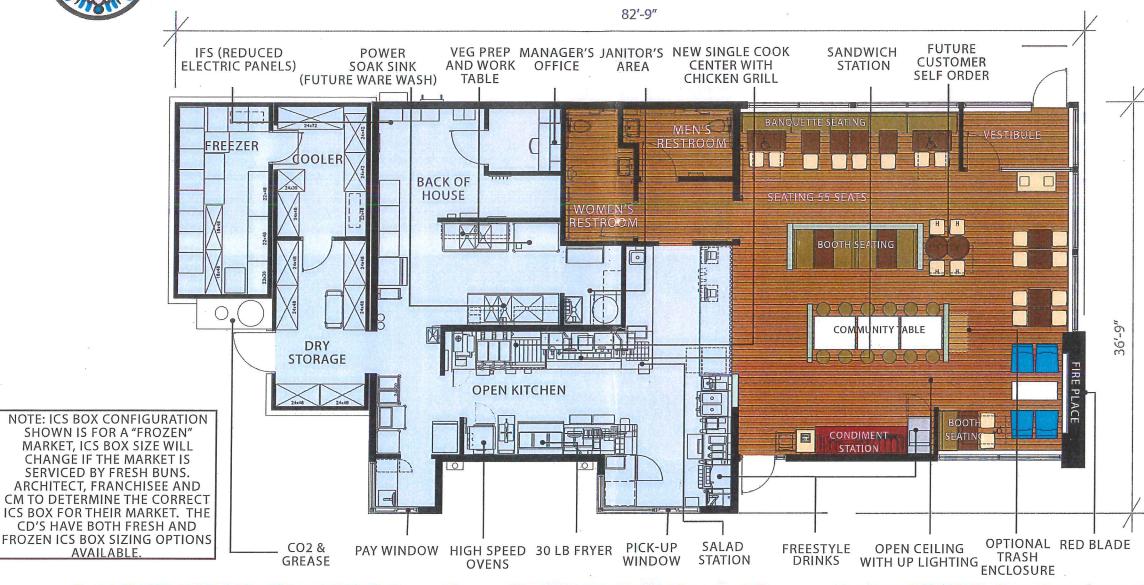U.S. SMART BUILDING

BUILDING AREA

2,479SF total footprint (Fresh market)2,562SF total footprint (Frozen market)

992sF dining / customer service

1,023sF kitchen / prep

149sf restrooms

315sF freezer / cooler / storage (Fresh market)
398sF freezer / cooler / storage (Frozen market)

DINING CAPACITY

55 total seats, excludes patio

19 total table tops, includes community table

BUILDING CHARACTERISTICS

24'-0" blade height

17'-6" parapet height

4 exterior building signs

BUILDING FEATURES

Single Line

2016 High Efficiency HVAC E-Flex System

SITE PLANNING CHARACTERISTICS

2 curb cuts with full circulation around the building

11 car drive-thru stack

450SF patio (12'x24' min.) with 12 seats (3 table tops)


Accessible route from public walk

Site lighting to achieve 4-6FC avg. (2FC min.)







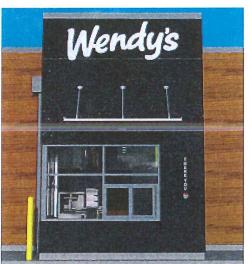





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EXTERIOR DESIGN ELEMENTS



SIGNATURE RED BLADE

Red Blade positioned on the front left side of the building. with white Wendy's logo and cameo. Aluminum storefront glazing with high windows. Out door Patio seating with umbrellas provide a special feature.


Red Blade material is Nichiha fiber cement. Color: Blaze PPG 333-7



WENDY'S CAMEO

60" LED cameo framed on the side elevation provides an eye catching display for oncoming traffic.


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GRAY PUW BLADE

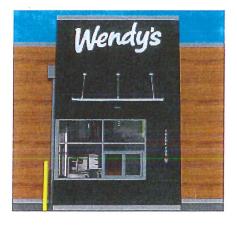Gray color Pick-Up window Blade with white Wendy's logo. New aluminum awningsupported with wire cables and down light fixture.

Gray Blade material is Nichiha fiber board cement. Color: Knight Armor PPG 1001-6



DRIVE-THRU AWNING

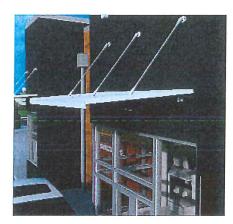The pre-fab powder coated drive-thru canopies have been slimmed and simplified, providing a perfect balance between form and function.

INTERIOR DESIGN ELEMENTS



HIGH OPEN CEILING

The dinig room has high open ceilings surrounded by glass and aluminum storefront. Interior lighting provides ambient uplighting that enhances the dining experience.



WENDY'S MURAL

Integration of Wendy's logo and LED accent lighting to make an impactful marketing statement.



COMMUNITY TABLE

The dining room furniture includes a new community wood table.
The SQE 55 community table seats 12.
The red fire place and TV adds to the dining room experience.



TECHNOLOGY

Introduction of the Customer Self Ordering (CSO) Front and center as customers enter the restaurant.



USB SQE 55 COVER SHEET











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USB SQE 55 SEATING LAYOUT



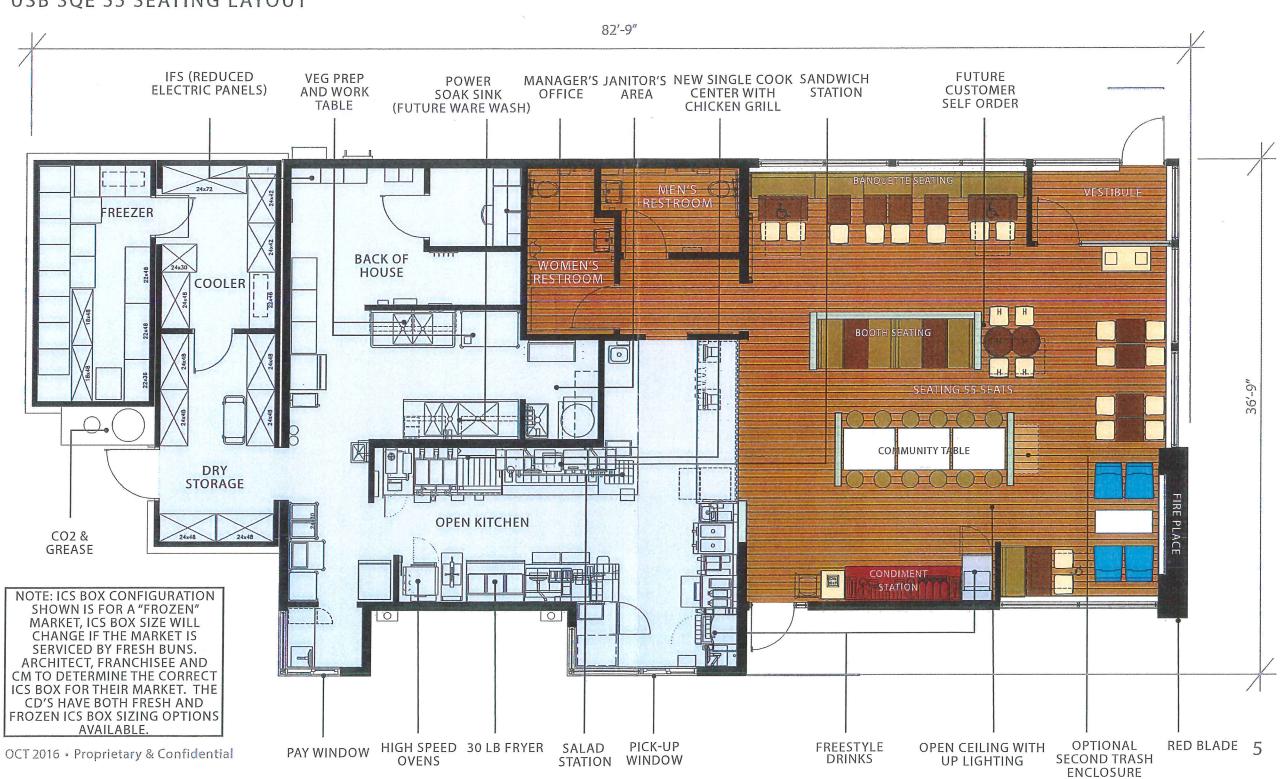


FRANCHISE XXXXXXXXX

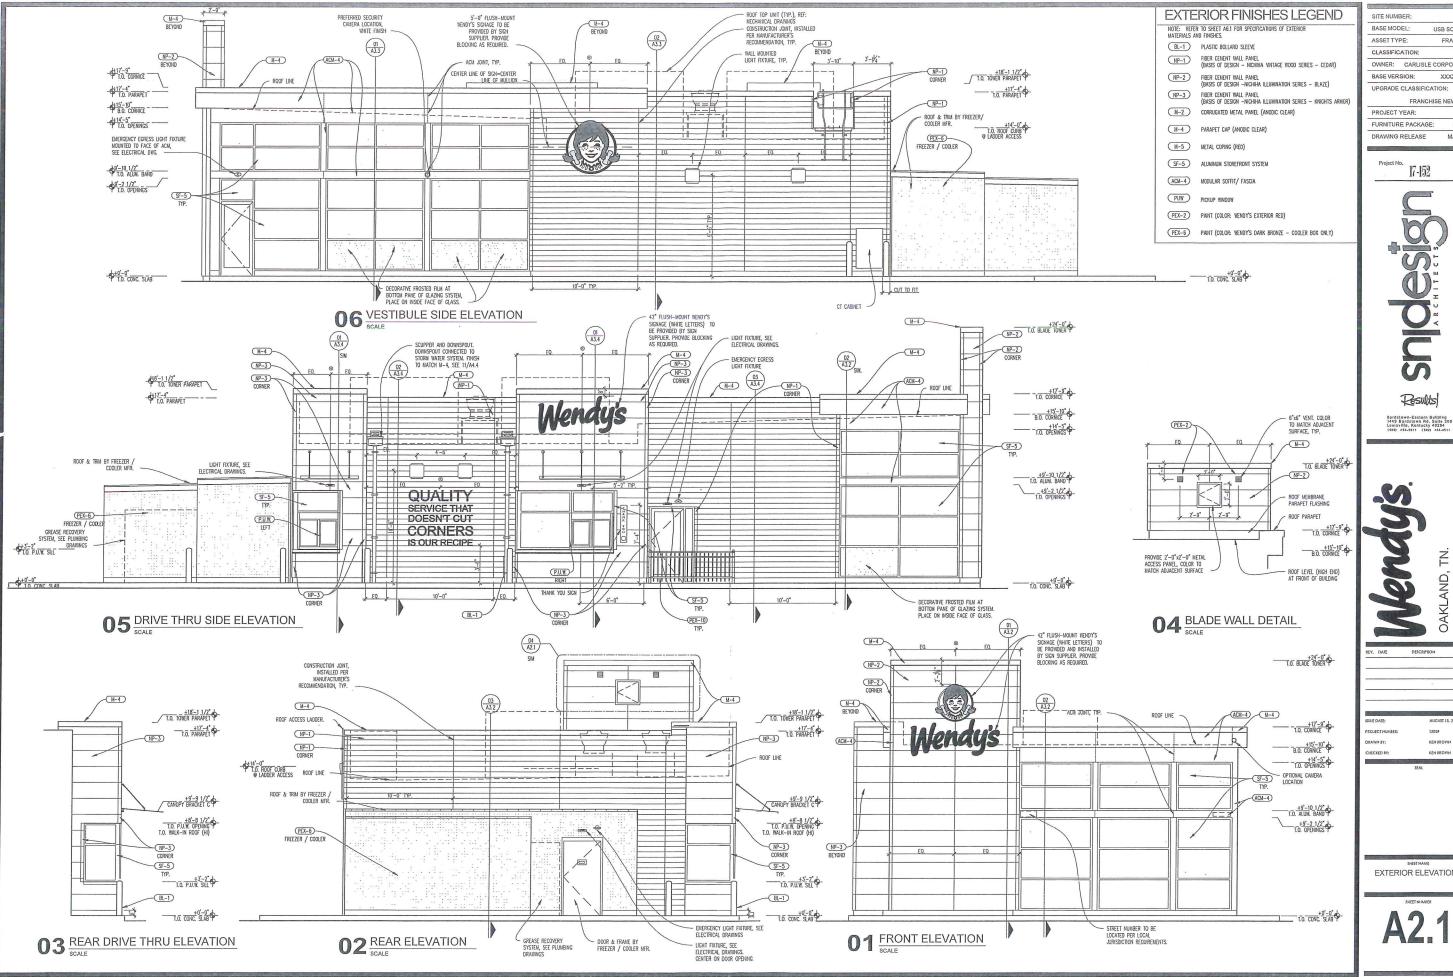DRAWING RELEASE MAR 2017




EXTERIOR ELEVATIONS

LEGEND		
COMMON NAME	QTY	SIZE
FLOWER, PERENNIAL LIRIOPE, BIG BLUE	77	1GAL.
SHRUB, DECIDUOUS ROSE, KNOCKOUT	19	3 GAL.
SHRUB, EVERGREEN BROADLEAF BURGUNDY LOROPETALUM CLEYERA INDIAN HAWTHORNE	19	3 GAL. 3 GAL. 3 GAL.
SHRUB, EVERGREEN CONIFER ARBOVITAE	2	15 GAL.
Tree, Deciduous Crapemyrtle	32	15 GAL.

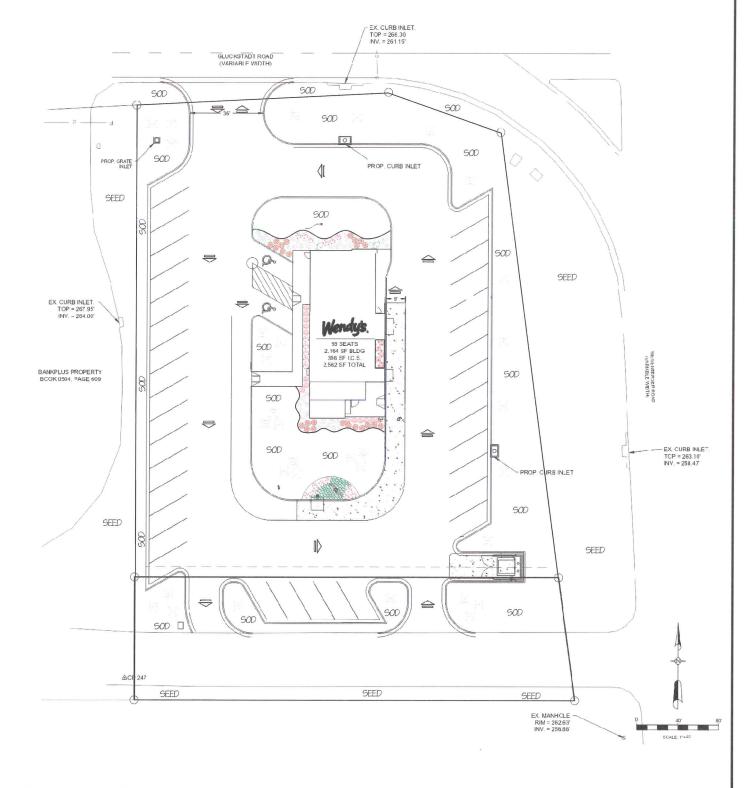


		REVISIONS				DRAWN BY:	SHEET NO
10.	DATE	DESCRIPTION BY WENDY'S	Landscape Plan	CHECK BY:	SHEETING		
+				NEW BUILD MADISON COUNTY, MISSISSIPPI		SCALE: 1" = 27	
					DATA	DATE:	
					PATH	PROJECT NO.: C-075-13-17	

FOR WENDY'S SITE #12175 NEW BUILD 1243 GLUCKSTADT ROAD MADISON COUNTY, MISSISSIPPI NOVEMBER 2017

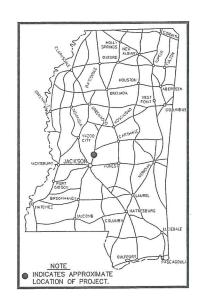

LOCATION MAP

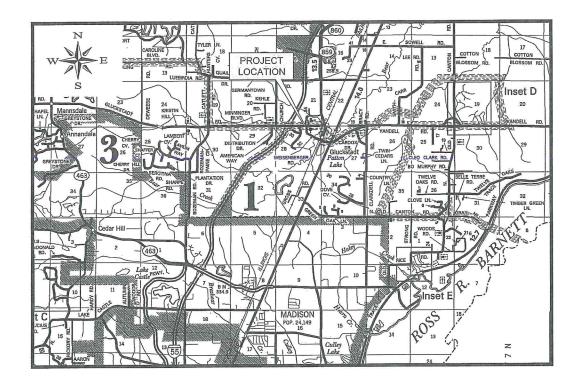

	SHEET INDEX
SHEET NO.	TITLE
C-1.0	COVER SHEET
C-1.1	LEGEND, ABBREVIATIONS AND GENERAL NOTES
C-2.1	SITE PLAN
C-2.2	GRADING AND DRAINAGE PLAN AND SPOT GRADES
C-2.3	EROSION CONTROL PLAN
C-3.1	TYPICAL PARKING, DRAINAGE, AND EROSION CONTROL DETAILS
C-3.2	PRE-CAST CURB INLET DETAILS
C-3.3	TYPICAL WATER DETAILS
C-3.4	TYPICAL SANITARY SEWER DETAILS



VICINITY MAP

SCALE: 1" = 5000'



854 WILSON DRIVE, SUITE A RIDGELAND, MS 39157 TEL 601-899-5158 FAX 601-899-5110

NOTICE TO THE DRAWING HOLDER

MENDROP ENGINEERING RESOURCES, LLC, HEREINAFTER REFERRED TO AS THE ENGINEER, HAS PREPARED AND FURNISHED THESE CONSTRUCTION PLANS TO THE OWNER FOR USE ON THIS PROJECT ONLY. THESE PLANS SHOULD NOT BE USED ON EXTENSIONS OF THIS PROJECT OR ON ANY OTHER PROJECT, ANY REUSE OF THESE PLANS, WITHOUT WRITTEN VERIFICATION OR ADAPTATION BY THE ENGINEER, SHALL BE AT THE REUSER'S SOLE RISK AND THE REUSER SHALL INDEMNIFY AND HOLD HARMLESS THE ENGINEER FOM ALL CLAIMS, DAMAGES, LOSSES, AND EXPENSES, INCLUDING ATTORNEY'S FEES ARISING OUT OF OR RESULTING THEREFROM.

NO.	DATE	DESCRIPTION	BY
1 .	12/18/2017	INITIAL SUBMITTAL FOR REVIEW	BG
2	12/20/2017	SUBMITTED FOR COUNTY APPROVAL	BG
		V	***

LEGEND

	SUBJECT/PROPERTY BOUNDARY
	PROP. RIGHT OF WAY
——	PROPERTY LINE
	PROP. CENTERLINE
	PROP. EASEMENT
——— SF ———— JS ———	PROP. SILT FENCE
	PROP. DITCH OR SWALE
	PROP. CONTOUR MAJOR
(301)	PROP. CONTOUR MINOR
	PROP. SETBACKS
	PROP. CONSTRUCTION LIMITS/DAYLIGHT LINES
	EX. EDGE OF PAVEMENT
	EX. MINOR CONTOUR
	EX. MAJOR CONTOUR
	PROP. DRAINAGE PIPE
8"W	PROP. WATER LINE (WITH SIZE)
8"SS	PROP. GRAVITY SEWER MAIN (WITH SIZE)
8"W	EX. WATER MAIN (WITH SIZE)
4"SS SS,,,†	EX. GRAVITY SEWER MAIN (WITH SIZE)
——— SS ———— SS ———	EX. SANITARY SEWER SERVICE
4"G 5.,†	EX. GAS LINE (WITH SIZE)
——— P ——— d ———	EX. OVERHEAD POWERLINE
	PROP. GRATE INLET
\$	EX. SEWER MANHOLE
菜	EX. FIRE HYDRANT
₩v ⊠	EX. WATER VALVE
Ф	EX. POWER POLE
	CURB INLET
	HORIZONTAL CONTROL POINT
\Rightarrow	LIGHT POLE
	TRAFFIC FLOW ARROW
\Longrightarrow	DRAINAGE FLOW ARROW
⊕ <u>&</u> ©	BENCHMARK / VERTICAL CONTROL POINT
گ	HANDICAP
	IRON PIN/PROPERTY CORNER
\bigcirc	EX. TELEPHONE PEDISTAL
(1)	EX. WATER METER

ABBREVIATIONS EX. EXISTING PROP. PROPOSED PM. PLAN MEASURE 4H ABSORBED HAUL CLASS GROUP AVERAGE END AREA FINAL MEASURE FINAL MEASURE FINAL MEASURE EMBANKMENT GAUGE CONTINUOUS VISTING MANHOUE "OSED MANHOU" "OL POIN" EX. PROP. PM AH CL GP AEA FME GA CONT. EMH PMH CP TYP. O.C. INV. REQ'D LS FINAL MEASURE EMBANKME GAUGE CONTINUOUS EXISTING MANHOLE PROPOSED MANHOLE CONTROL POINT CORRUGATED METAL PIPE TYPICAL ON CENTER EACH WAY TOP OF CURB INVERT FI EVATION REQUIRED LUMP SUM ACRES CUBIC YARDS LINEAR FEET EACH EACH POUNDS VERTICAL FOOT STATION POINT OF CURVATURE POINT OF REVERSE CURVATURE WATER VALVE HYDRANT POINT OF TAGENCY LEFT RIGHT VERTICAL CURVE EASTING UPSTREAM DOWNSTREAM FLOW LINE REINFORCED CONCRETE PIPE REINFORCED CONCRETE ARCH PIPE RCAP SQUARE YARD SQUARE FOOT PIPE COLLAR R.O.W. O/S BC-1 F.B. RIGHT-OF-WAY OFFSET BRANCH CONNECTION FLAT BOTTOM

GENERAL NOTES:

- 1. BEFORE COMMENCING ANY ACTIVITY UNDER OR PERTAINING TO THIS CONTRACT, THE CONTRACTOR SHALL:
- 1.1. OBTAIN ALL BUILDING AND CONSTRUCTION PERMITS AS REQUIRED BY PERTINENT REGULATORY AND
- GOVERNMENTAL AGENCIES;
 1.2. CONTACT MADISON COUNTY INSPECTION OFFICE;
 1.3. VERIFY THE LOCATION OF EXISTING UTILITIES ON THE PROJECT SITE A MINIMUM OF 72 HOURS BEFORE CONSTRUCTION OPERATIONS BEGIN;
- AT ALL TIMES, THE CONTRACTOR SHALL EMPLOY ADEQUATE EROSION AND SEDIMENTATION CONTROL MEASURES TO
 PREVENT DAMAGE TO THE PROPERTY, ADJACENT PROPERTIES, PUBLIC RIGHTS-OF-WAY, AND PUBLIC OR PRIVATE
 DRAINAGE SYSTEMS. ALL NEWLY CUT AND/OR FILLED AREAS LACKING ADEQUATE VEGETATION SHALL BE SEEDED
 AND/OR SODDED AS REQUIRED TO EFFECTIVELY PREVENT SOIL EROSION PER MDEQ REGULATIONS.
- THE CONTRACTOR MUST HAVE WRITTEN APPROVAL FROM MADISON COUNTY BEFORE ANY CHANGE IN THE DESIGN IS MADE.
- 4. AT NO TIME SHALL THE CONTRACTOR ENCROACH UPON OR CAUSE DISRUPTION TO TRAFFIC FLOW ON ADJACENT PUBLIC RIGHTS-OF-WAY WITHOUT SECURING THE PROPER PERMITS PRIOR TO COMMENCING OPERATIONS. THE CONTRACTOR SHALL ERECT THE PROPER TRAFFIC CONTROL DEVICES PET HE MANUAL OF UNIFORM TRAFFIC CONTROL DEVICES, LATEST EDITION, AND SHALL PROTECT THE PUBLIC FROM HAZARD OR INJURY BY ERECTING BARRICADES WHERE APPROPRIATE. THE CONTRACTOR SHALL NOT ENTER NOR CAUSE DAMAGE TO ANY ADJACENT PROPERTIES WITHOUT WRITTEN PERMISSION FROM SAID PROPERTY OWNERS.
- 5. UNLESS NOTED OTHERWISE, ALL SITE CONCRETE SHALL BE 4,000 PSI.
- 6. ANY EXISTING UTILITIES REQUIRING RELOCATION SHALL BE THE CONTRACTOR'S RESPONSIBILITY. THE CONTRACTOR IS RESPONSIBLE FOR MAINTAINING WORKING UTILITY SERVICES TO ADJACENT BUILDINGS DURING DEMOLITION AND CONSTRUCTION. COORDINATE ALL PLANNED SERVICE OUTAGES OR EMERCENCIES WITH THE OWNER. ANY UTILITY DAMAGED BY CONSTRUCTION ACTIVITIES SHALL BE REPLACED AND RESTORED TO ITS ORIGINAL CONDITION AT NO ADDITIONAL CONST TO THE OWNER.
- 7. CONSTRUCTION STAKING IS THE RESPONSIBILITY OF THE CONTRACTOR.
- CONTRACTOR SHALL COMPLY WITH ALL APPLICABLE LOCAL AND STATE REQUIREMENTS INCLUDING THE LOCAL NOISE ORDINANCE.
- ANY FENCING, SIDEWALK, CURB AND GUTTER, CURB CUT, ETC., DAMAGED BY CONSTRUCTION ACTIVITIES SHALL BE REPLACED AND RESTORED TO ITS ORIGINAL CONDITION AT NO ADDITIONAL COST TO THE OWNER.
- 10. ALL UTILITY LINES ENTERING THE BUILDING SHALL BE SEALED TO PREVENT MIGRATION OF SURFACE AND SUBSURFACE WATER AND SUBSEQUENT WETTING OF THE SUBGRADE SOILS. THE UTILITY LINES SHALL BE SEALED FROM THE BUILDING FOUNDATION TO A MINIMUM OF 3 FEET OUTSIDE THE BUILDING FOUNDATION.
- 11. CONTRACTOR SHALL FIELD VERIFY LOCATION OF EXIST NATURAL GAS, WATER, AND SEWER LINES WHERE CROSSING PROPOSED UTILITIES' CONSTRUCTION. CONTRACTOR SHALL PROVIDE ELEVATIONS OF EXIST UTILITIES TO THE ENGINEER TO VERIFY ADEQUATE CLEARANCE.
- 12. CONTRACTOR SHALL SUPPLY AND INSTALL ALL ITEMS AND PERFORM ALL WORK NOT COVERED BY UTILITY COMPANIES. VERIFY INSTALLATION PROCEDURE WITH UTILITY COMPANY.
- 13. CONTRACTOR SHALL REMOVE AND REPAIR PAVEMENT AS REQUIRED FOR UTILITY CONSTRUCTION INCLUDING BUT NOT LIMITED TO: IRRIGATION SLEEVES, SITE LIGHTING, CONDUITS, WATER LINES, SANITARY SEWER LINES, STORM DRAINAGE LINES, ETC. CONTRACTOR HAS OPTION TO BORE CONDUITS.

		REVISIONS	
NO.	DATE	DESCRIPTION	E

WENDY'S SITE #12175 **NEW BUILD** 1243 GLUCKSTADT ROAD MADISON COUNTY, MISSISSIPPI

LEGEND, ABBREVIATIONS AND GENERAL NOTES

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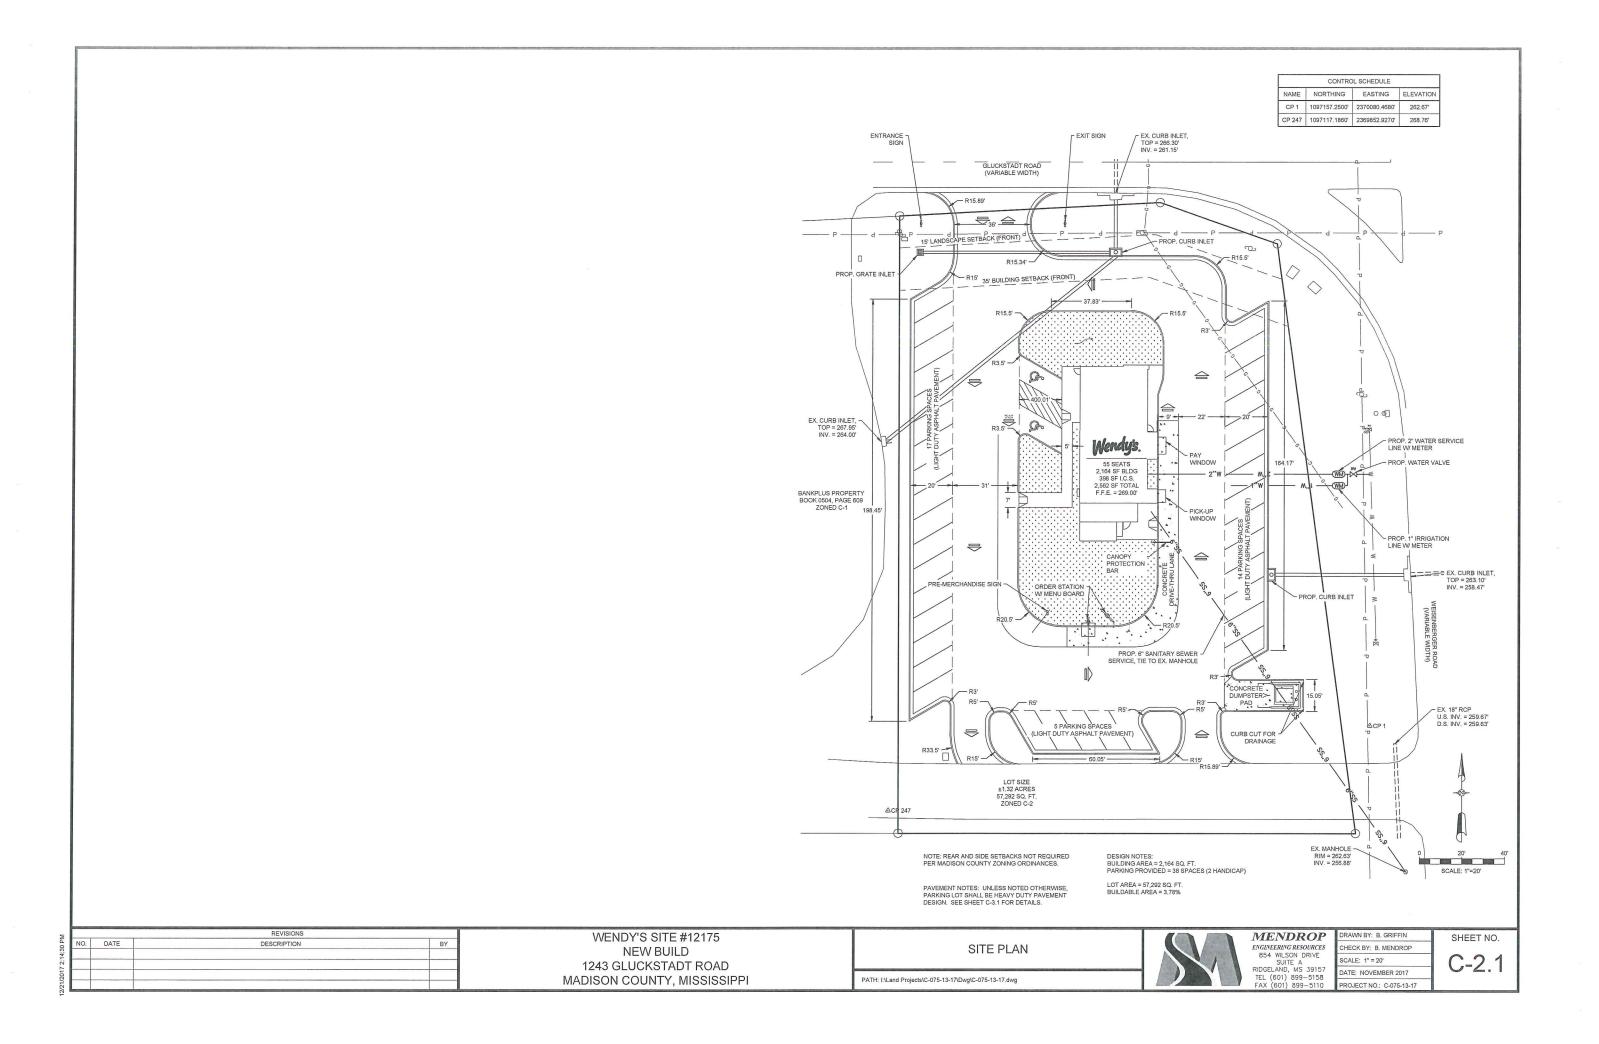
MENDROP ENGINEERING RESOURCES 854 WILSON DRIVE SUITE A RIDGELAND, MS 39157 TEL (601) 899-5158 FAX (601) 899-5110

DRAWN BY: B. GRIFFIN SCALE: NONE

DATE: NOVEMBER 2017

PROJECT NO.: C-075-13-17

SHEET NO.




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	LAYOU'	T POINTS	
POINT NO.	NORTHING	EASTING	DESC./TYPE
1000	1097392.90'	2369885.19'	EP
1001	1097377.91'	2369885.19'	EP
1002	1097363.62'	2369876.94'	EP
1003	1097356.55'	2369864.69'	EP
1004	1097273.00'	2369864.70'	EP
1005	1097162.71'	2369864.70'	EP
1006	1097170.07'	2369877.45	EP
1007	1097166.18'	2369884.20'	EP
1008	1097154.17'	2369884.20'	EP
1009	1097153.66'	2369899.20'	EP
1010	1097159.13'	2369899.20'	EP
1011	1097165.63'	2369905.68'	EP
1012	1097165.64'	2369907.23'	EP
1013	1097162.41'	2369912.87'	EP
1014	1097145.68'	2369922.60'	EP
1015	1097145.86'	2369978.03'	EP
1016	1097156.09'	2369972.08'	EP
1017	1097165.85'	2369977.68	EP
1018	1097165.88'	2369986.96'	EP
1019	1097159.38'	2369993.48'	EP
1020	1097153.85'	2369993.48'	EP
1021	1097154.48'	2370008.48'	EP
1022	1097161.47'	2370008.50	EP
1023	1097185.45	2370015.98'	EP
1024	1097193.82'	2370030.48'	EP
1025	1097228.25'	2370030.48'	EP
1026	1097353.37	2370030.48'	EP
1027	1097345.72'	2370017.23	EP
1028	1097349.62'	2370010.48	EP
1029	1097362.73'	2370010.48'	EP
1030	1097376.23'	2369996.98'	EP
1031	1097376.23'	2369959.93'	EP
1032	1097376.23	2369934.67'	EP
1033	1097393.07'	2369918.19'	EP
1034	1097319.75'	2369934.69	TOC
1035	1097330.58'	2369915.94'	TOC
1036	1097333.61'	2369914.19'	TOC
1037	1097336.73'	2369914.19'	TOC
1038	1097352.23'	2369929.69'	TOC
1039	1097352.23'	2369967.52'	TOC
1040	1097336.73'	2369983.02	TOC
1041	1097322.12'	2369983.02'	TOC
1042	1097318.86'	2369982.50'	TOC
1043	1097312.68'	2369980.48'	TOC
1044	1097255.57'	2369980.48'	TOC
1045	1097253.57'	2369980.48'	HC RAMP
1046	1097250.57'	2369980.48'	HC RAMP
1047	1097248.57'	2369980.48'	TOC
1048	1097224.26'	2369980.48'	TOC
1049	1097203.76'	2369959.98'	TOC
1050	1097203.76'	2369934.69'	тос
1051	1097224.26'	2369914.19	TOC
1052	1097259.72'	2369914.19'	тос
1053	1097261.72'	2369914.69'	HC RAMP
1054	1097264.72'	2369914.69'	HC RAMP
1055	1097266.72'	2369914.19'	тос
1056	1097290.89	2369914.19'	тос
1057	1097293.92'	2369919.44'	TOC
1058	1097285.11'	2369934.69'	TOC
1059	1097298.93'	2369934.69'	TOC
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1060 1097300.93' 2369934.69' HC RAMP

LAYOUT POINTS				
POINT NO.	NORTHING	EASTING	DESC./TYP	
1061	1097303.93'	2369934.69'	HC RAMP	
1062	1097305.93'	2369934.69'	TOC	
1063	1097326.05'	2369934.69'	sw	
1064	1097299.68'	2369939.69'	sw	
1065	1097266.72'	2369934.69'	sw	
1066	1097259.72	2369939.69'	sw	

STRUCTURE	SIZE	TOP OF	PIPE DIA.		INVERT	
NO.	(INSIDE CLEAR)	CURB/GRATE	IN	OUT	IN	OUT
CI-1	3' x 5'	266.50	***	18"		260.00
CI-2	3' x 5'	265.50	15"	18"	261.60	261.50
GI-1	2' x 2'	264.75		15"		260.00

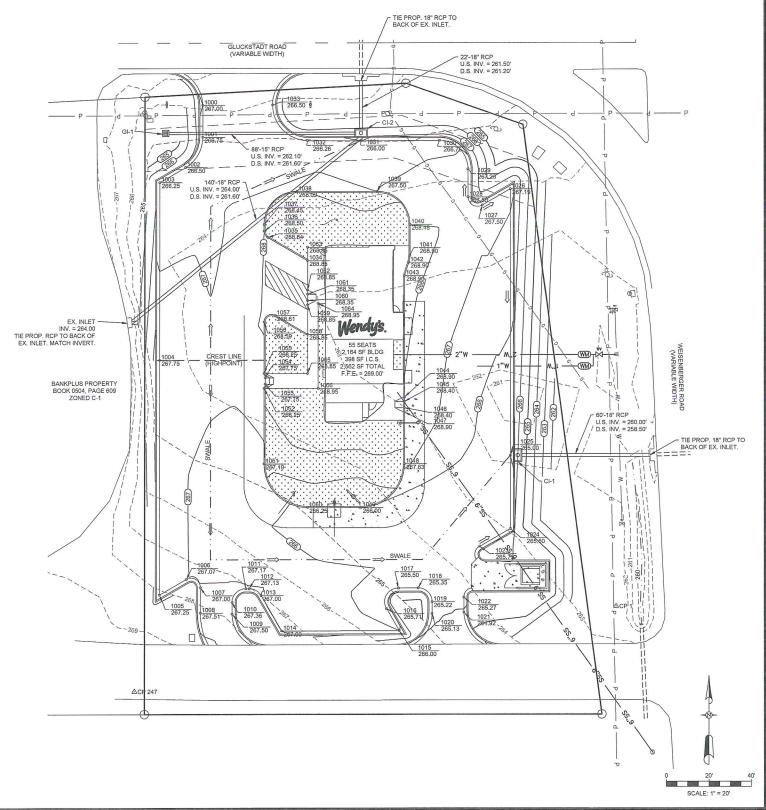

DESCRIPTION B'

WENDY'S SITE #12175 **NEW BUILD** 1243 GLUCKSTADT ROAD MADISON COUNTY, MISSISSIPPI

GRADING AND DRAINAGE PLAN AND SPOT GRADES


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MENDROP ENGINEERING RESOURCES 854 WILSON DRIVE SUITE A RIDGELAND, MS 39157 TEL (601) 899–5158 FAX (601) 899–5110

RAWN BY: B. GRIFFIN CHECK BY: B. MENDROP SCALE: 1" = 20' DATE: NOVEMBER 2017 ROJECT NO.: C-075-13-17

SHEET NO.



		REVISIONS	
NO.	DATE	DESCRIPTION	BY
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WENDY'S SITE #12175 NEW BUILD 1243 GLUCKSTADT ROAD MADISON COUNTY, MISSISSIPPI

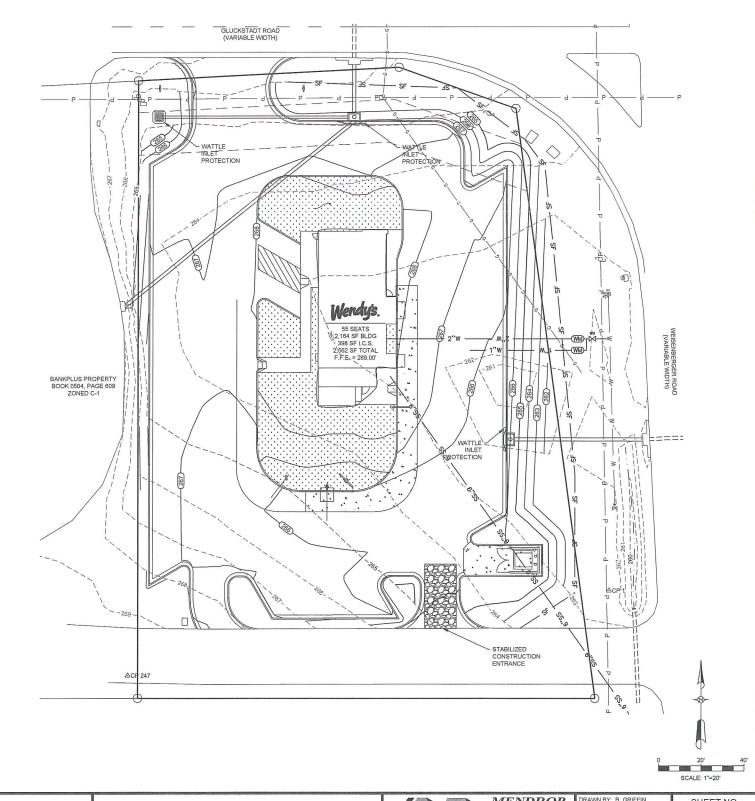
EROSION CONTROL PLAN

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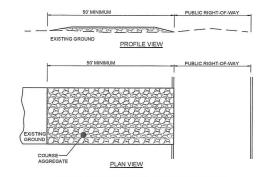
DRAWN BY: B. GRIFFIN SHEET NO. CHECK BY: B. MENDROP SCALE: 1" = 20' DATE: NOVEMBER 2017 PROJECT NO.: C-075-13-17



TEMPORARY SILT FENCE DETAIL

SILT FENCING NOTES:

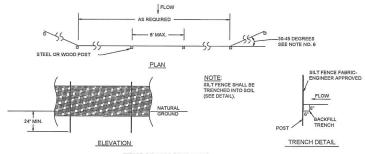- SILT FENCE OR HAY BALE SEDIMENT BARRIER SHALL BE INSTALLED TO FILTER SEDIMENT FROM RUNOFF.
 SEDIMENT BUILD-UP SHALL BE REMOVED WHEN SEDIMENT BEACHES 1/2 THE ABOVE GROUND HEIGHT OF THE FENCE.
 SILT FENCE SHALL BE LEFT IN FACE UNTLY, FERMANENT VEGETATION COVER IS ESTREIGHED.
 AREAS DISTURBED AS A RESULT OF REMOVING THE SILT FENCE SHALL BE RESTABILIZED BY SEEDING ACCORDING TO THE REVEGETATION




STABILIZED CONSTRUCTION ENTRANCE DETAILS NOT TO SCALE

CONSTRUCTION ENTRANCE NOTES:

- SEPARATION BOTESTILE FABRIC FOR FULL WIDTH AND LENGTH OF EXIT.

 GRADE TO PREVENT RUN-OFF FROM LEAVING SITE PROVIDE APPROPRIATE TRANSITION BETWEEN STABILIZED CONSTRUCTION ENTRANCE AND PUBLIC RIGHT-OF-WAY.

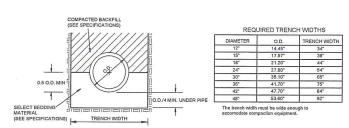

STORM DRAIN TRENCH CROSS-SECTION

PIPE BEDDING AND INSTALLATION NOTES

DISACTION OF THE PROPERTY OF THE REQUIREMENTS OF ASSISTED FOR 284, LATEST EDITION. DESIGNATION OF TYPE: TYPE S: THIS PIPE WILL HAVE A FULL CIRCULAR CROSS SECTION, WITH AN OUTER CORRUGATED PIPE WALL AND A SMOOTH INNER LINER.


BEDDING MATERIAL AND STRUCTURAL BACKFILL BEDDING AND STRUCTURAL BACKFILL SHALL MEET THE REQUIREMENTS OF TABLE 1.

- 2. JOINTS
 JOINTS HERMOPLASTIC PIPE SHALL MEET THE PERFORMANCE REQUIREMENTS OF SOILTIGHTNESS UNLESS WATERTIGHTNESS IS SPECIFIED,
 SUITABLE JOINTS CAN BE OBTAINED WITH THE FOLLOWING TYPES OF CONNECTIONS:
 A) CORRUCATED BANDS WITH OR WITHOUT GASKETS)
 B) BELL AND SPROOT PIPE FANDS (WITH OW WITHOUT GASKETS)
 C) DOUBLE BELL COUPLINGS (WITH OR WITHOUT GASKETS)

3. INSTALLATION
MINIMUM TRENCH WIDTHS SHALL MEET THE REQUIREMENTS OF TABLE 2. THE MIDDLE THIRD OF THE BEDDING MATERIAL UNDER THE PIPE
SHOULD BE LOOSELY PLACED, WHILE THE REMAINDER SHALL BE COMPACTED TO A MINIMUM 90% OF MAXIMUM DENSITY PER AASHTO T 99.
STRUCTURAL BACKFILL SHALL BE PLACED AND COMPACTED IN LAYERS NOT EXCEEDING AN 8 INCH LOOSE LIFT THICKNESS AND BROUGHT!
EVENLY ON BOTH SIDES OF THE PIPE TO AN ELEVATION NOT LESS THAN 12 INCHES ABOVE THE TOP OF THE PIPE, A MINIMUM COMPACTION
OF 90% STANDARD DENSITY PER AASHTO T99 SHALL BE ACHIEVED.

AASHTO GROUP CLASSIFICATION	A-1		A-3	A-2	
	A-1-a	A-1-b		A-2-4	A-2-5
SIEVE ANALYSIS, PERCENT PASSING:					
2.00 MM (NO. 10)	50 MAX				
0.425 MM (NO. 40)	30 MAX	50 MAX	51 MIN		
0.075 MM (NO. 200)	15 MAX	25 MAX	10 MAX	35 MAX	35 MAX
CHARACTERISTICS OF FRACTION PASSING 0,425 MM (NO, 40)					
LIQUID LIMIT	_			40 MAX	41 MIN
PLASTICITY INDEX	6 N	1AX	NP	10 MAX	10 MAX
USUAL TYPE OF SIGNIFICANT CONSTITUENT MATERIALS	STONE FF	RAGMENTS.	FINE SAND	SILTY O	R CLAYEY
	GRAVEL A	ND SAND		GRAVEL A	AND SAND
MDOT GRANULAR MATERIAL DESIGNATION (SECTION 703.07)	CLASS 1&2.	CLASS 3&4.		CLASS 5&6,	GROUP C
	GROUP A	GROUP A	1	1	

HDPE PIPE BEDDING DETAILS

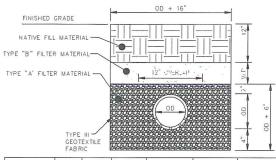

PIPE SIZE	Т	К	TYPE "A" MATERIAL (yd3/ft)	TYPE "B" MATERIAL * (yd3/ft/ft)	TYPE III GEOTEXTILE (yd ² /ft)	NATIVE FILL MATERIAL (yd ³ /ft)
6"		==	0.0638	0.0694	0.7593	0.0694
18"	<i>Y</i> :	4"	0.099	0.130	1.193	
24"	3	2"	0.100	0.148	1.334	
30"	1/2	2"	0.124	0.167	1.513	
36"	4	2"	0.149	0.185	1.691	
42"	W.	2"	0.176	0.204	1.869	
48"	5"	2"	0.204	0.222	2.048	

* NOTE: yd 3/ft/ft = CUBIC YARD PER FOOT DEPTH OF MATERIAL PER FOOT LENGTH OF PIPE.


UNDERDRAIN NOTES:

- $6^{\prime\prime}$ Overlap shall be required at the end of each roll of type III geotextile.
- TYPE A FILTER MATERIAL SHALL CONSIST OF COARSE AGGREGATE GRAVEL OR CRUSHED LIMESTONE UNLESS OTHERWISE DESIGNATED, AND SHALL MEET THE REQUIREMENTS FOR SIZE 7, 57, OR 67 COURSE AGGREGATE FOR PROTLAND CEMENT CONCRETE SET FORTH IN THE MISSISSIPPI STANDARD SPECIFICATIONS FOR ROAD AND BRIDGE CONSTRUCTION.
- TYPE B FILTER MATERIAL SHALL CONSIST OF NATURAL OR MANUFACTURED LIMESTONDE SAND, AND MEET THE REQUIREMENTS OF FINE AGGREGATE FOR PROTLAND CEMENT CONCRETE SET FORTH IN THE MISSISSIPPI STANDARD SPECIFICATIONS FOR ROAD AND BRIDGE CONSTRUCTION.
- PVC PIPE USED FOR UNDERDRAINS SHALL CONFORM TO ASTM D 3034 FOR SDR 35.

TYP. UNDERDRAIN INSTALLATION DETAIL NOT TO SCALE





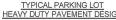


- (1) 3" HOT BITUMINIOUS SURFACE COURSE (SC-1, TYPE 8) OR HMA, ST, 9.5MM MIX
- ② 1.5" HOT BITUMINIOUS SURFACE COURSE (SC-1, TYPE 8) OR HMA, ST, 9.5MM MIX
- 3 2.5" HOT BITUMINIOUS BINDER COURSE (BC-1, TYPE 6) OR HMA, ST, 19MM MIX
- 4 6" CRUSHED LIMESTONE (SIZE 610)







- (5) 6" FIBER REINFORCED CONCRETE PAVEMENT
- (6) 8" FIBER REINFORCED CONCRETE PAVEMENT
- 7 4" CRUSHED LIMESTONE (610 SIZE)

NOTE: PAVEMENT DESIGN RECOMMENDATION PROVIDED BY GEOTECHNICAL ENGINEER. REFER TO GEOTECHNICAL REPORT FOR DETAILS.

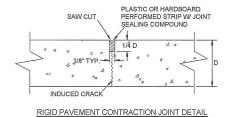


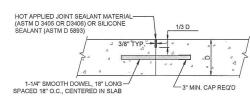


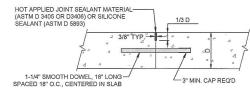


RIGID PAVEMENT DOWELED CONSTRUCTION JOINT



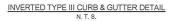


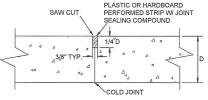


RIGID PAVEMENT BUTT CONSTRUCTION JOINT DETAIL

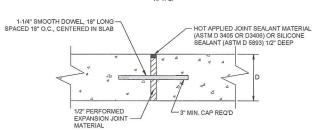

RIGID PAVEMENT EXPANSION JOINT DETAIL W/ DOWEL N. T. S.

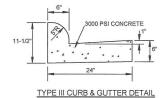

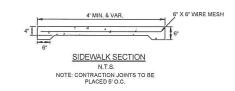

	Interior Control of the Control of t	REVISIONS	
NO.	DATE	DESCRIPTION	BY
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WENDY'S SITE #12175 **NEW BUILD** 1243 GLUCKSTADT ROAD MADISON COUNTY, MISSISSIPPI

TYPICAL PARKING, DRAINAGE, AND EROSION CONTROL DETAILS

PATH: I:\Land Projects\C-075-13-17\Dwg\C-075-13-17.dwg




MENDR

ENGINEERING RESC 854 WILSON DRIVE SUITE A RIDGELAND, MS 39157 TEL (601) 899-5158 FAX (601) 899-5110

OP	DRAWN BY: B. GRIFFIN
OURCES	CHECK BY: B. MENDROP
RIVE	SCALE: NONE
39157	

PROJECT NO.: C-075-13-17

SHEET NO.

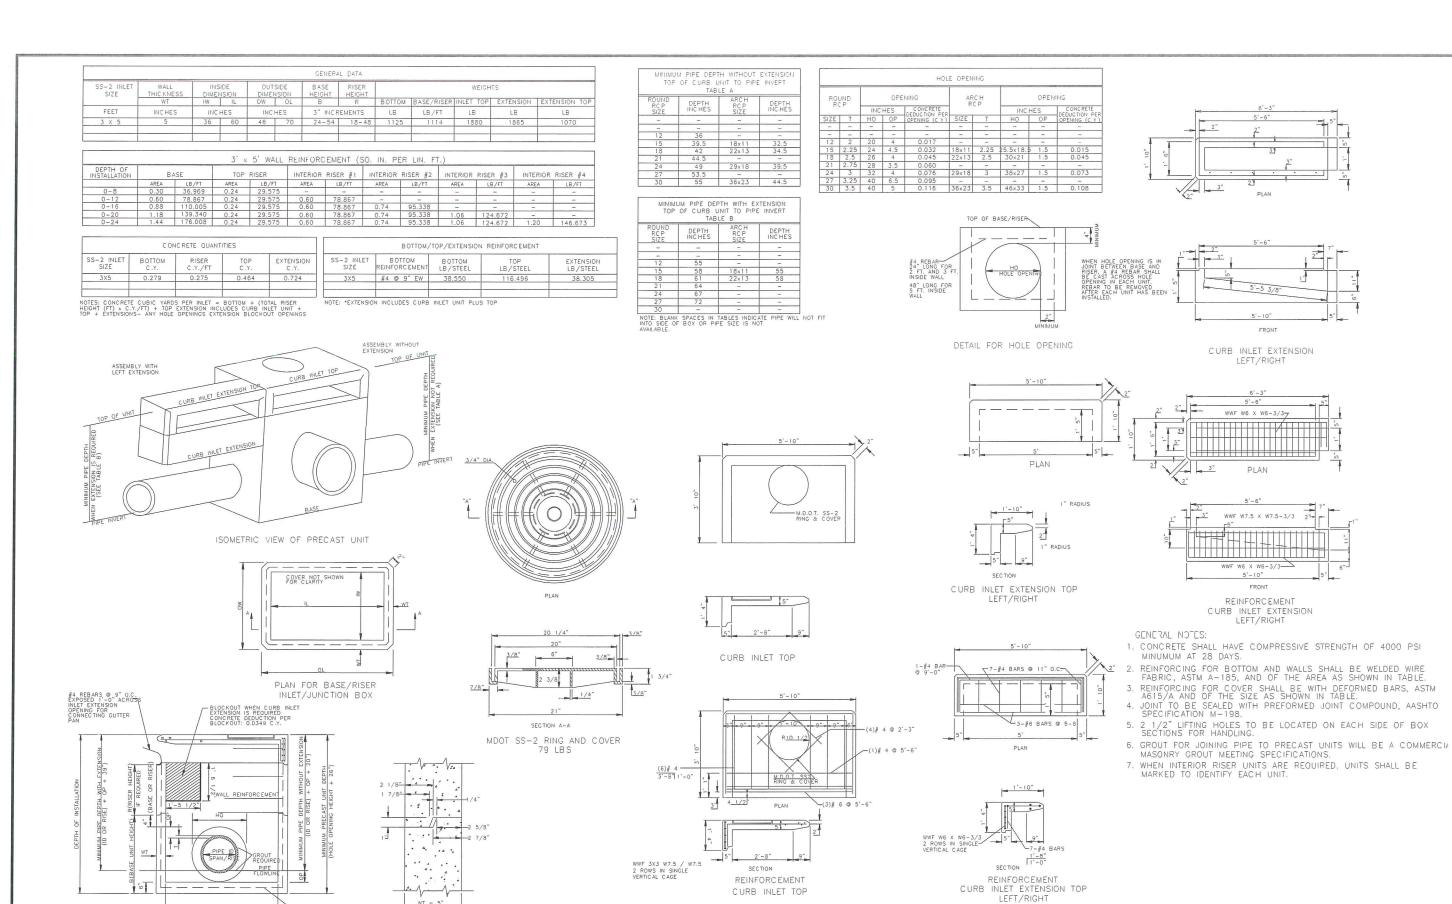

	REVISIONS				
NO.	DATE	DESCRIPTION	BY		

SECTION A-A

BOTTOM REINFORCEMENT

JOINT DETAIL

WENDY'S SITE #12175 NEW BUILD 1243 GLUCKSTADT ROAD MADISON COUNTY, MISSISSIPPI

PRE-CAST CURB INLET DETAILS

PATH: I:\Land Projects\C-075-13-17\Dwg\C-075-13-17.dwg



MENDROP ENGINEERING RESOURCES 854 WILSON DRIVE SUITE A RIDGELAND, MS 39157 TEL (601) 899-5158 FAX (601) 899-5110

DR DRAWN BY: B. GRIFFIN

CCES
VE
SCALE: NONE

DATE: NOVEMBER 2017

PROJECT NO: C-075-13-17

C-3.2

